


Ground Floor Plan First Floor Plan
SCALE 1:100 Second Floor Plan





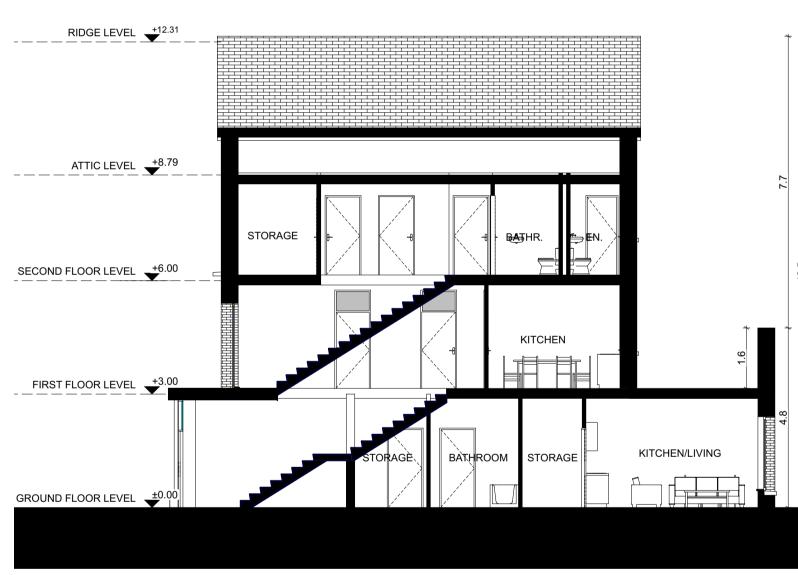

Roof Level

Area Type	Proposed Area	DoHPCLG Area Min
Duplex - DUP01 - Grour	nd Floor (2 bed) -	Gross Internal Area

**Side Elevation** 

DUP01 - 2 Bed Unit	86.1 m <sup>2</sup>	73.0 m <sup>2</sup>		
Duplex - DUP01 - Space Provision & Room Sizes				
Area Type	Proposed Area	DoHPCLG Area Min		
Aggregate Bedroom Area	24.5 m <sup>2</sup>	24.4 m <sup>2</sup>		

Duplex - DUP01 - Storage Provision		
Area Type	Proposed Area	DoHPCLG Area Min.
Storage	8.5 m <sup>2</sup>	6.0 m <sup>2</sup>
Refer to Site Plan for:	- Finished floor	levels to survey datum


Orientation

- Handing of type for each unit

Duplex - DUP01 - First Floor (3 bed) - Gross Internal Area			
Area Type	Proposed Area	DoHPCLG Area Min.	
DUP01 - 3 Bed Unit	132.0 m <sup>2</sup>	90.0 m <sup>2</sup>	
Duplex - DUP01 - Space Provision & Room Sizes			

Space Provision	& Room Sizes
Proposed Area	DoHPCLG Area M
$38.0 \text{ m}^2$	31.5 m <sup>2</sup>
43.4 m <sup>2</sup>	34.0 m <sup>2</sup>
	Proposed Area 38.0 m <sup>2</sup>

Aggregate Living Area	43.4 m <sup>2</sup>	34.0 m <sup>2</sup>	
Duplex - DUP01 - Storage Provision			
Area Type	Proposed Area	DoHPCLG Area Min.	
Storage	10.0 m <sup>2</sup>	9.0 m <sup>2</sup>	
Refer to Site Plan for:	<ul><li>Finished floor levels to survey datum</li><li>Orientation</li><li>Handing of type for each unit</li></ul>		

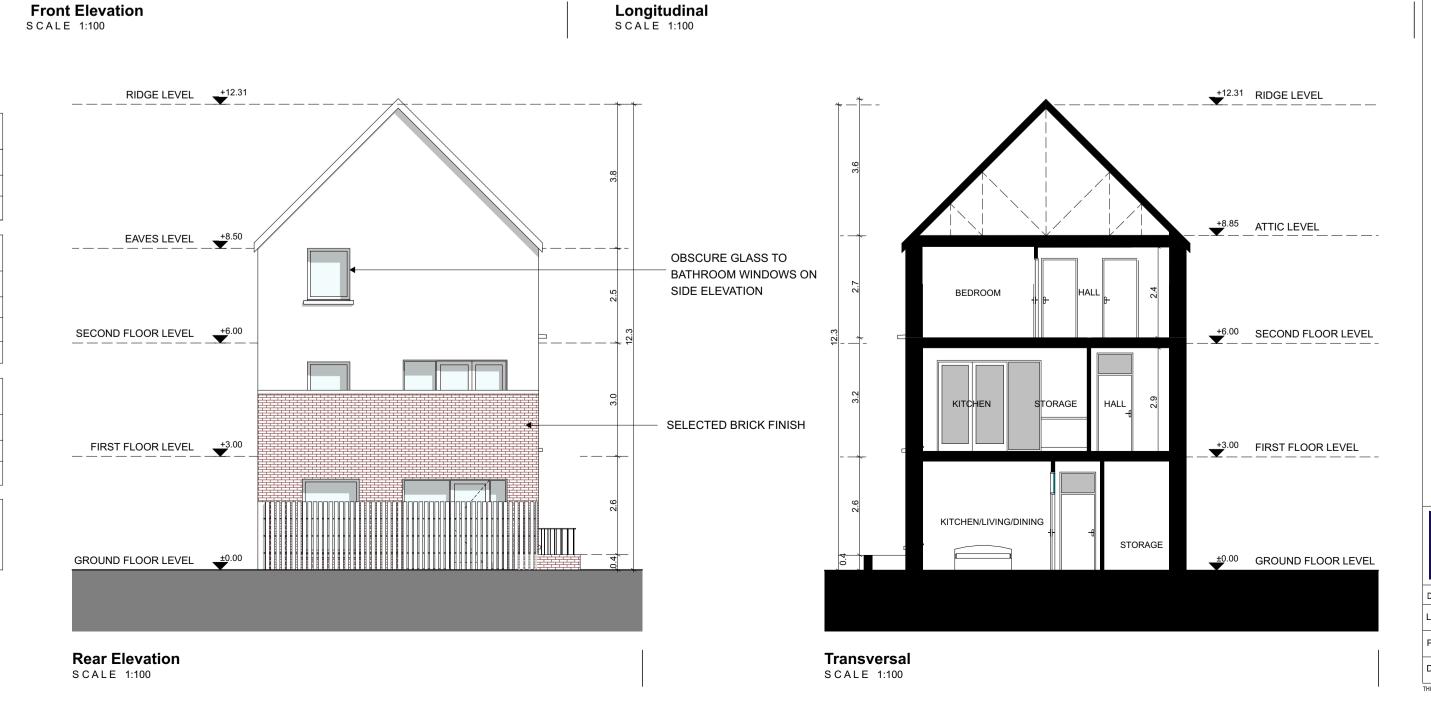


unless otherwise noted.

Do not scale from this drawing. Use figured dimensions only. All errors and omissions to be reported to the Architect. This drawing is to be read in conjunction with relevant consultant's drawings. All dimensions are in millimetres and all levels are in meters to match Datums

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2BED GROUND FLOOR APARTMENT

(86.1 sqm)

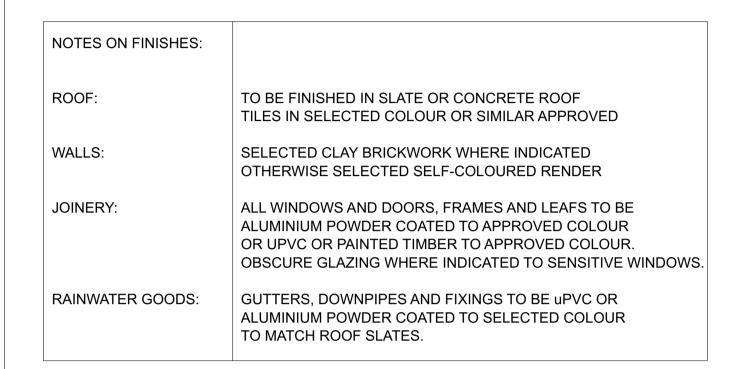3BED DUPLEX APARTMENT (132 sqm)

FOR ORIENTATION AND HANDING PLEASE REFER TO SITE PLAN





(DUI	(DUPLEX UNIT)			
RIAI	Planning Application	DAVEY + SMITH ARCHITECTS		
DAVEY+SMITH ARCHITECTS I 13 SEAPOINT BUILDING, 44/45 CLONTARF ROAD, CLONTARF, DUBLIN 3   PH: 01 2447638   EMAIL: info@davey-smith.com   WEB: www.davey-smith.com				
Layout ID: <b>D2101 - UT24</b>		Scale:	1:100	
Layout D. DETOT - STEP			Job No:	D2101
Project: Ashbourne SHD		Series:	Planning	
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Drawing Name: Type G1 Duplex - Proposed Floor Plans, Section, Elevations			Status:	Planning
Diawing Name. Type OT Duplex - 1 Toposed 1 1001 Figure 5, Section, Lievations				
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